


**PARTITION TYPE NOTES:**


- ALL FULL HEIGHT, FREE STANDING WALLS AND WALLS WITH ITEMS RECESSED INTO THEM SHALL BE 6" METAL FRAMING. BALANCE OF METAL FRAMING SHALL BE 3-5/8" METAL FRAMING UNLESS INDICATED OTHERWISE.
- WHEN ALIGNING WITH EXISTING WALL FURRING, WALL FURRING TO MATCH EXISTING.
- METAL FRAMING SHALL BE 24" ON CENTER WITH HORIZONTAL BRACING PER MANUFACTURE SPECIFICATION.
- DRYWALL SHALL BE AS INDICATED ON PARTITIONS UNLESS MATCHING AND ALIGNING WITH AN EXISTING WALL / WALL INFILL, THEN IT WILL MATCH EXISTING.
- PROVIDE SLIP-TRACK/RECEIVER AT THE TOP OF ALL PARTITIONS SUBJECT TO STRUCTURAL DEFLECTION PER GYPSUM BOARD MANUFACTURES REQUIREMENTS.
- GYPSUM BOARD: TYPICAL 1/2" GYP. BOARD USED UNLESS NOTED OTHERWISE. REMODEL PROJECTS USE 5/8" GYPSUM BOARD WHERE EXISTING 5/8" GYPSUM BOARD IS IN PLACE.
- FINISHED CEILINGS, EXTEND GYP. BD. 6" ABOVE CEILING, METAL STUDS DO NOT NEED TO EXTEND TO DECK (UNO) IF BRACED BACK TO STRUCTURE ABOVE AT 48" O.C. MAX.

**REFLECTED CEILING PLAN FINISH LEGEND**

KEY	DESCRIPTION
	NEW 2x4' SUSPENDED CLG PANELS & GRID SYSTEM. USE CEILING TILE AC-001/201.
	PAINT EXPOSED STRUCTURE, STEEL DECK, CONDUIT, UNISTRUT, PIPING & DUCTWORK TO MATCH EXISTING.
	EXISTING CEILING TO REMAIN UNLESS NOTED OTHERWISE.

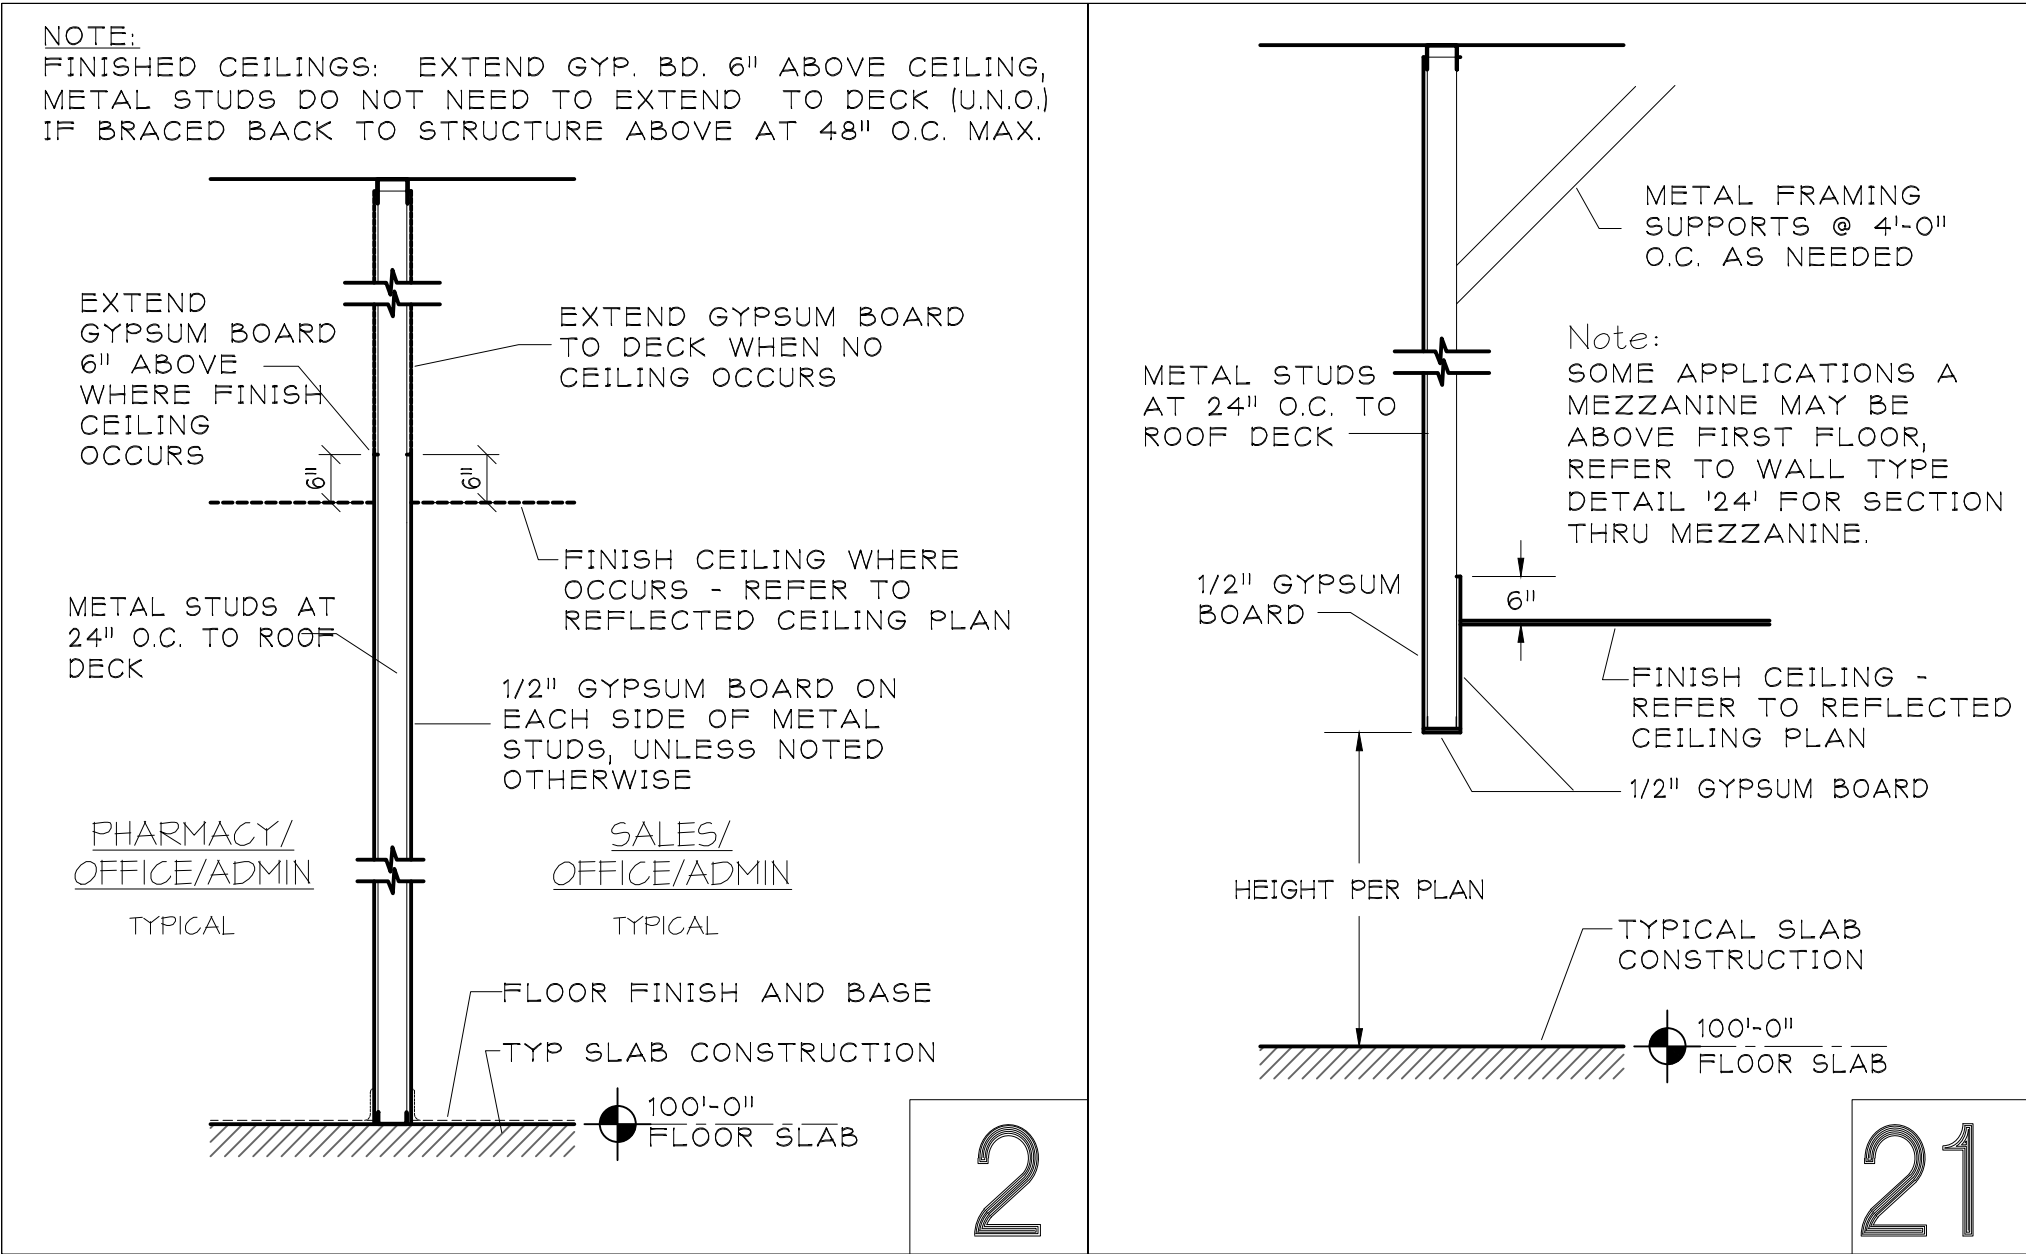


**PARTITION TYPES**

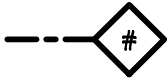

**REFLECTED CEILING PLAN GENERAL NOTES:**

- SEE MECHANICAL AND ELECTRICAL DRAWINGS FOR ADDITIONAL INFORMATION AND REQUIREMENTS.
- COORDINATE HVAC AND MECHANICAL WITH LIGHTING LAYOUT AND STRUCTURAL LAYOUT.
- REMOVE EXISTING FIXTURES COMPLETE FROM AREAS TO BE DEMOLISHED & AS INDICATED ON THE RELECTED CEILING PLAN & ELECTRICAL DRAWINGS.
- EXISTING LIGHT FIXTURES TO BE REMOVED, REMAIN OR BE RELOCATED AS INDICATED. SEE ELECTRICAL DRAWINGS FOR ADDITIONAL INFORMATION AND REQUIREMENTS.
- EXISTING NON-EXPOSED AREA TO BE CONVERTED TO EXPOSED STRUCTURE. EXISTING DUCTS, ELECTRICAL LINES, CONDUITS, JUNCTION BOXES, REFRIGERATION LINES, LOW VOLTAGE AND OTHER EXISTING ITEMS TO BE REWORKED TO THE STURCTURE & PREPED TO RECEIVE PAINT. PAINT TO MATCH EXPOSED STRUCTURE - SEE MECHANICAL DRAWINGS FOR DUCT WORK CHANGES.
- REFER TO ELECTRICAL DRAWINGS TO VERIFY WHICH LIGHT FIXTURES SHALL BE PROVIDED BY KROGER AND INSTALLED BY THE CONTRACTOR.
- COORDINATE WITH ELECTRICAL DRAWINGS FOR LOCATION OF ALL EMERGENCY AND BACKUP LIGHTS.
- G.C. SHALL BE RESPONSIBLE FOR COORDINATION OF ALL MECHANICAL, PLUMBING, REFRIGERATION, ELECTRICAL WITH LOCAL AUTHORITIES HAVING JURISDICTION AND ALL OTHER BUILDING TRADES. CARE SHALL BE TAKEN TO PROTECT EXISTING ITEMS SCHEDULED FOR REUSE.
- REWORK EXISTING FIRE SUPPRESSION SYSTEM THIS AREA AS REQUIRED TO ACCOMMODATE NEW CONFIGURATION. ALL REVISIONS TO THE FIRE SUPPRESSION SYSTEM TO BE TREATED AS A DEFERRED SUBMITTAL BY G.C. REVISION TO BE DESIGNED AND SEALED BY A LICENSED ENGINEER AND MEET ALL RELEVANT STATE AND LOCAL CODES. (ALL WORK/DESIGN/REVISIONS TO BE APPROVED BY KROGERS UNDERWRITER).
- ALL NEW AND EXISTING REFRIGERATION/CONDUIT LINES TO BE PAINTED TO MATCH ADJACENT EXPOSED STRUCTURE OR WALL.
- DEMO EXISTING CEILING, SOFFITS AND WALLS COMPLETE. PREP EXISTING STRUCTURE TO BECOME EXPOSED STRUCTURE. REWORK DUCTS, CABLES, CONDUITS ETC. AS SHOWN AND AS REQUIRED.
- PAINT NEWLY EXPOSED STRUCTURE TO MATCH EXISTING EXPOSED STRUCTURE OVER THE SALES FLOOR. NUMBER OF COATS AS REQUIRED TO COVER EXIST'G, CONTRACTOR TO DETERMINE NUMBER OF COATS REQ'D.
- PAINT ALL EXISTING AND NEW ELECTRICAL FEED FROM CEILING TO TRACK LIGHT, WHITE.

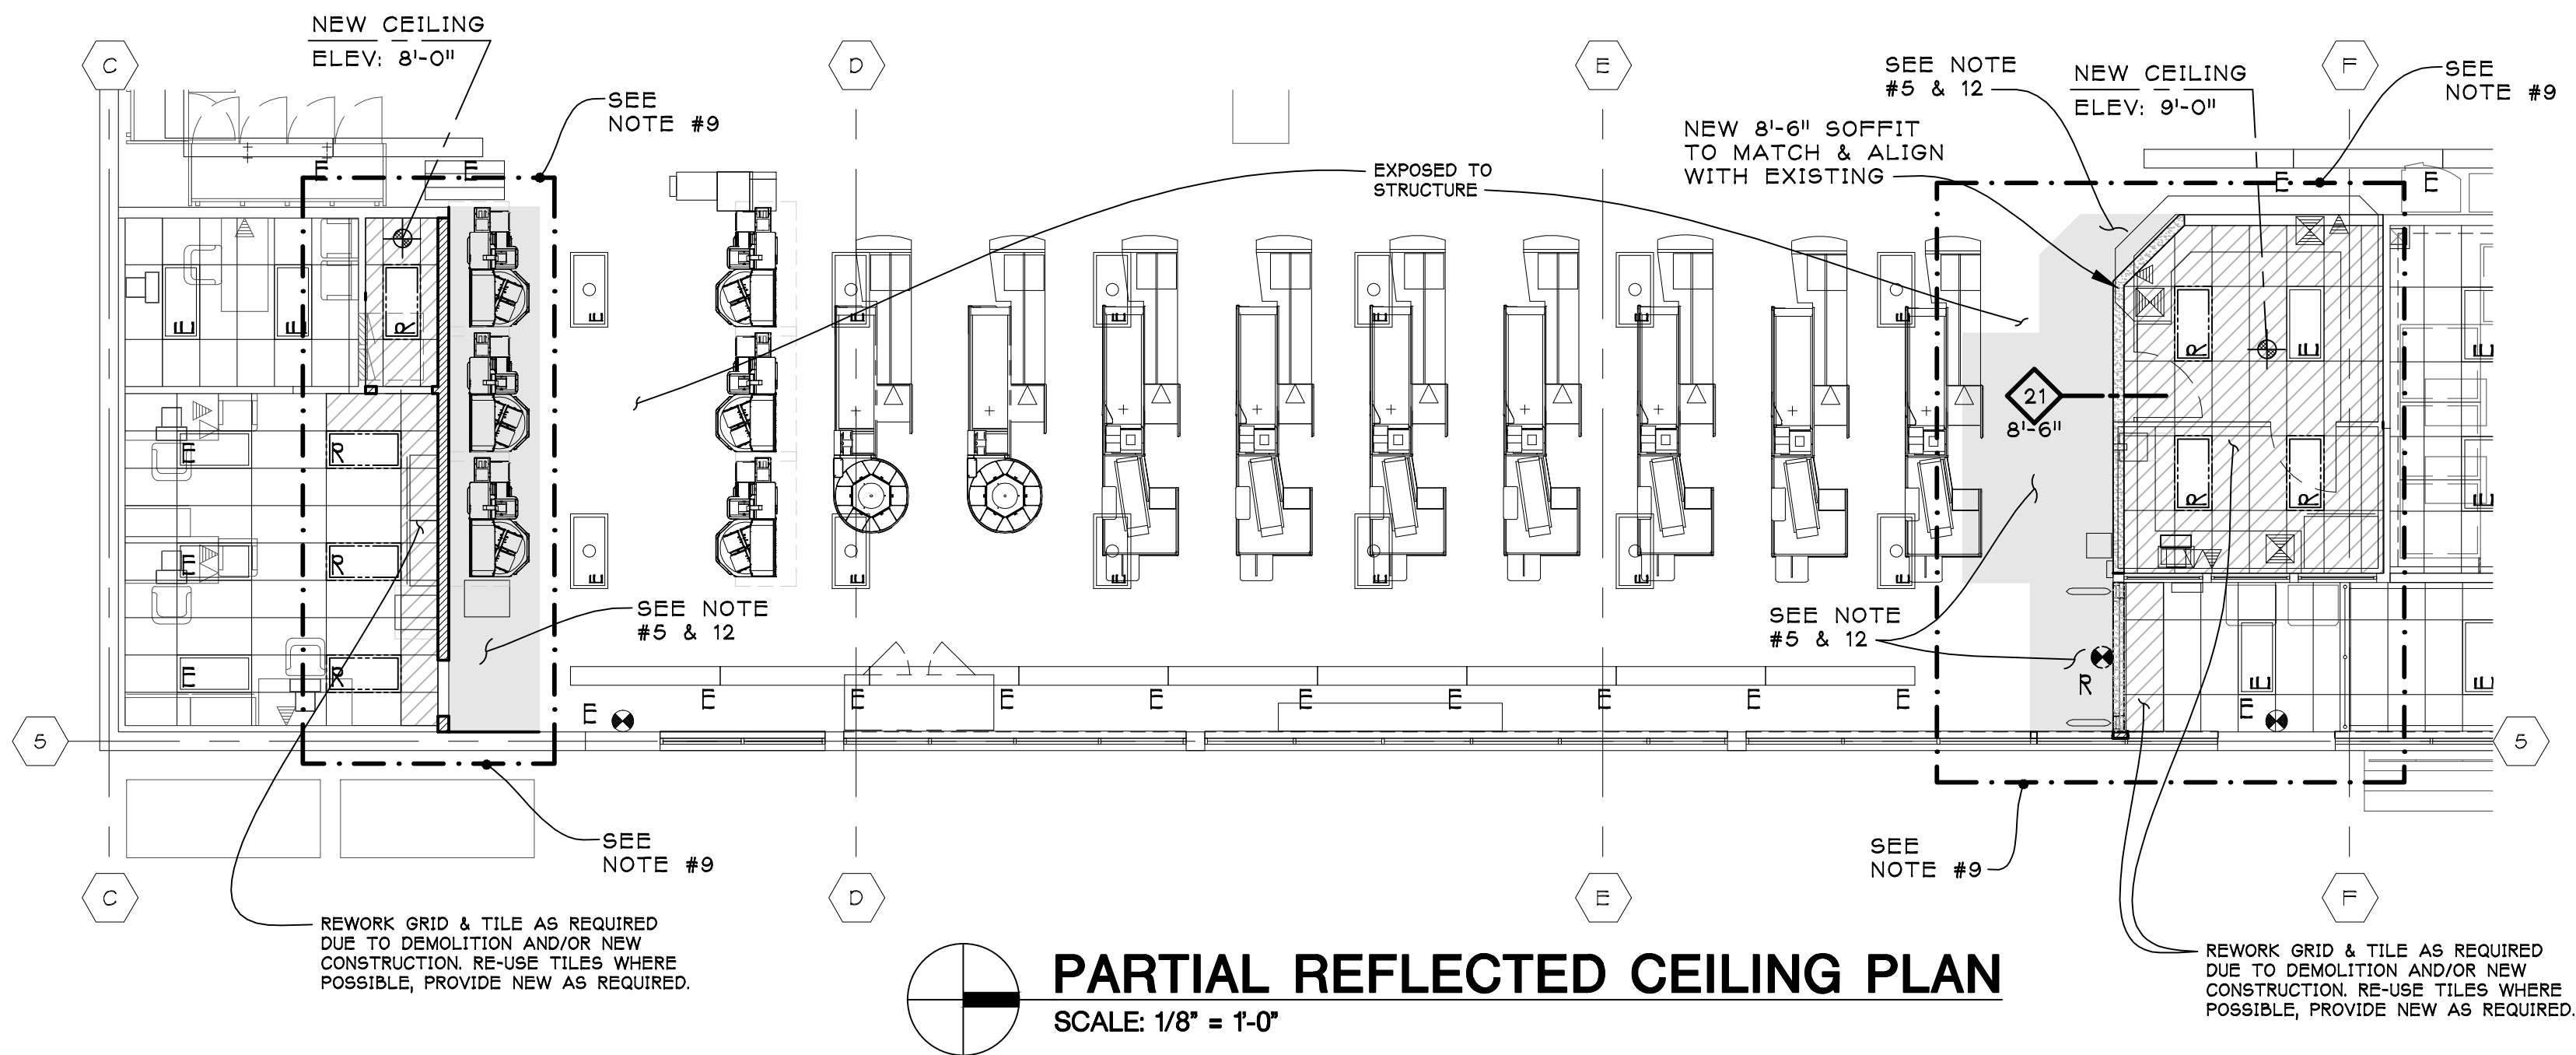


STORE NO. D-447; JOB NO. 1211

ROOM NAME	STATUS	DOOR NO.	DOOR OPENING SIZE	DOOR		FRAME				HARDWARE		REMARKS		
				TYPE	MAT'L	WALL WIDTH	TYPE	MAT'L	DETAILS THIS SHEET	LBL.	HARDWARE GROUP # SEE KROGER INSTALLATION SPECIFICATION FOR INDIVIDUAL COMPONENTS	NOTES	SUPPLIED BY	INSTALLED BY
VESTIBULE	(RELOCATED)	1013	6'-0"x7'-0" PAIR	C	ALUM	7"	SF	ALUM	2	NONE	GROUP #17	MATCH EXISTING FIELD VERIFY; 1	GC	GC
CO-MANAGER	(RELOCATED)	132	3'-0"x7'-0"	EXIST	EXIST	7"	EXIST	EXIST	1	NONE	GROUP #11	2, 3	GC	GC
COAT CLOSET	(RELOCATED)	134	3'-0"x7'-0"	EXIST	EXIST	4 5/8"	EXIST	EXIST	1	NONE	GROUP #10 DO NOT INSTALL A CLOSER ON THIS DOOR	2, 3	GC	GC
ECR	(EXISTING)	201	EXISTING TO REMAIN	EXIST	EXIST	--	EXIST	EXIST	--	NONE	RELOCATE EXISTING ECR PUSH BUTTON LOCK / LOCKSET	2, 3	GC	GC

NOTES:

- EXISTING AUTOMATIC DOOR PACKAGE WITH SIDELIGHTS TO BE RELOCATED. GLAZING PROVIDED BY GENERAL CONTRACTORS TRADE.
- PAINT ALL DOORS AND FRAMES PER SPECIFICATION, NEW, EXISTING, & RELOCATED.
- PROVIDE APPROPRIATE TRANSITION STRIP AT NEW DOOR (TO MATCH EXISTING).

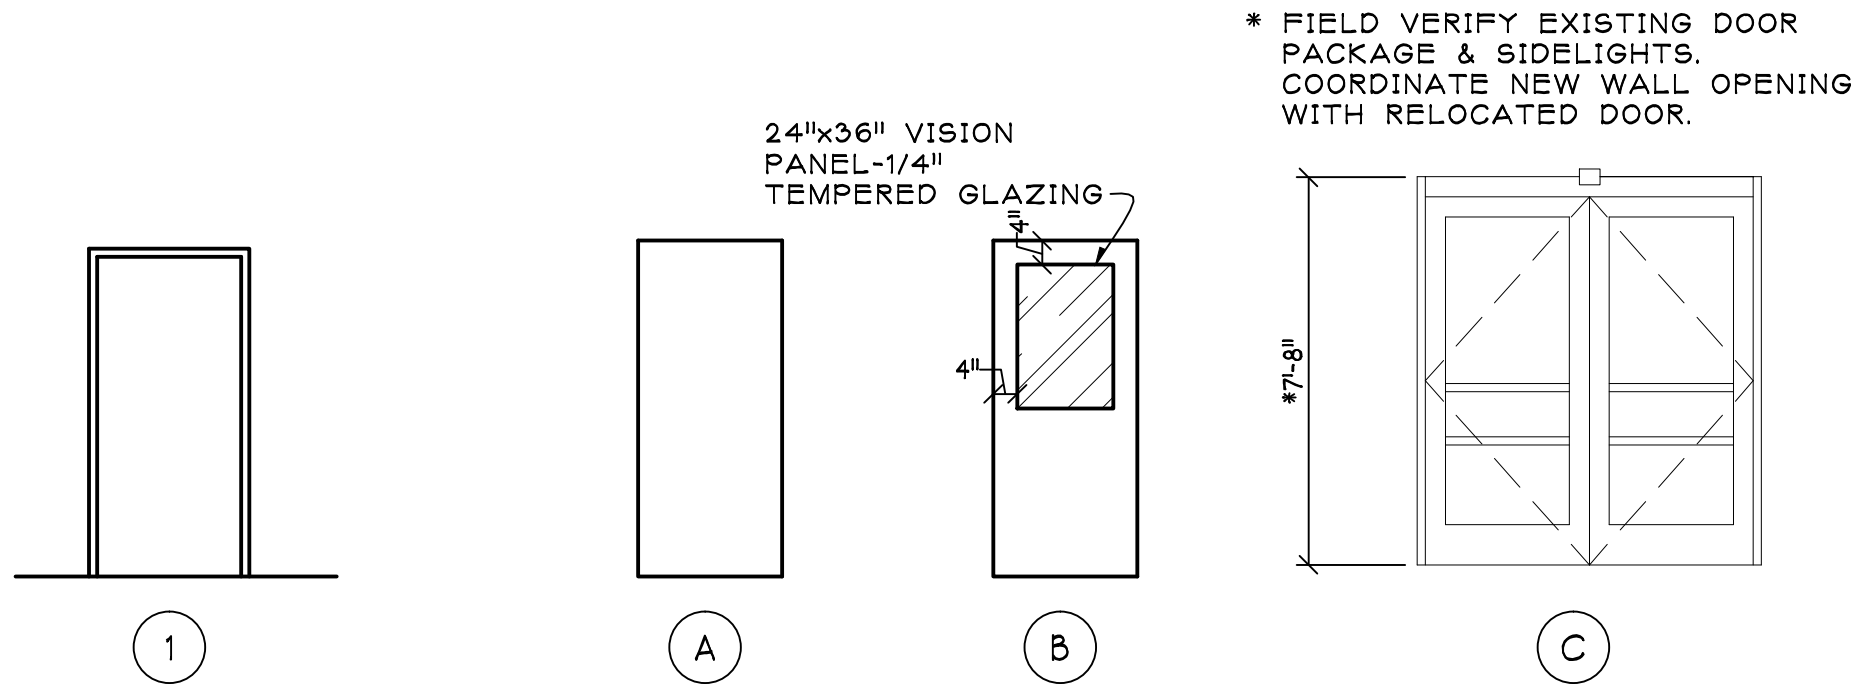


**DOOR FRAME TYPES**

NO SCALE


**DOOR TYPES**

SCALE: 1/4" = 1'-0"

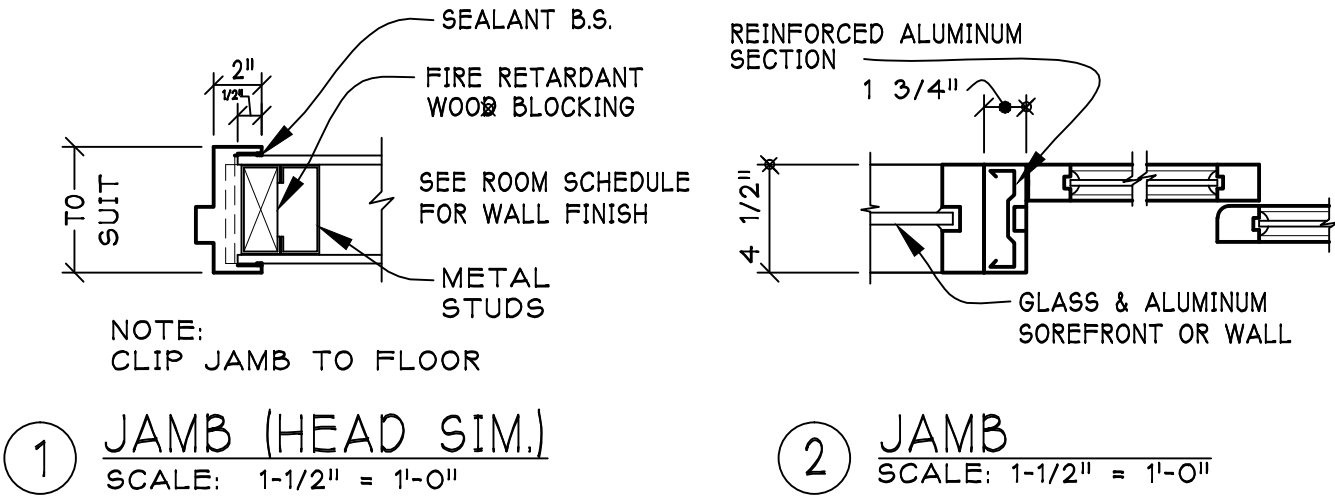

**DOOR FRAME DETAILS**

SEE PARTITION TYPES FOR ADDITIONAL INFORMATION AND REQUIREMENTS.

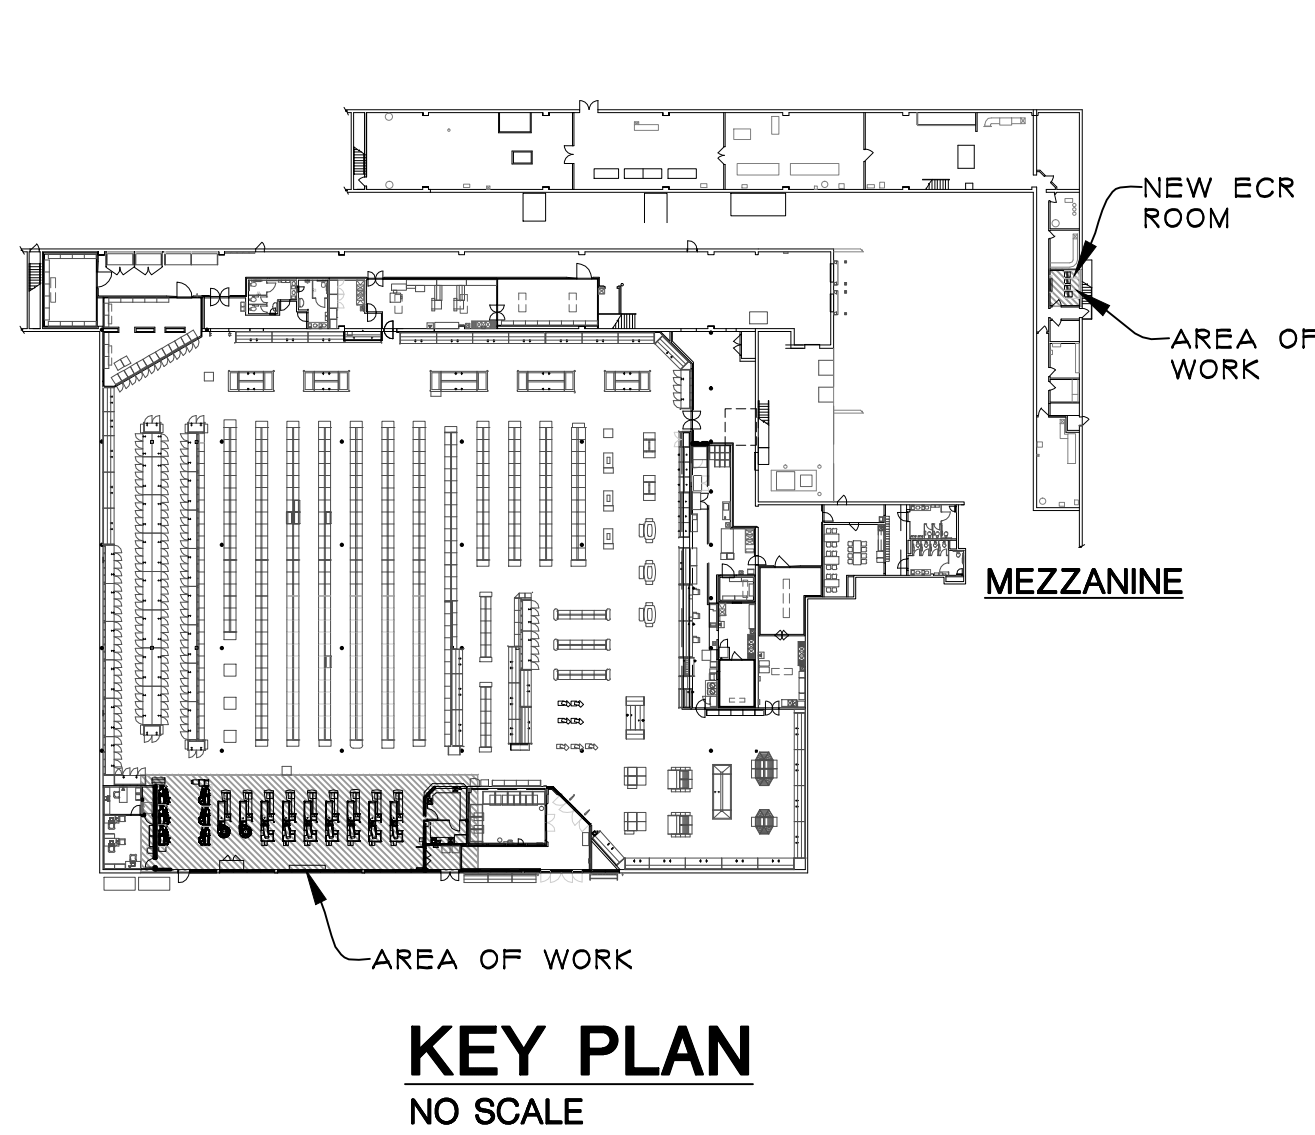

ADDENDUM NO 1  
BIDS & PERMITS  
OWNER REVIEW

ISSUED FOR:

PROPOSED MINOR REMODEL FOR:

**Kroger**

STORE NO. D-447

23101 JOHN R ROAD  
HAZEL PARK, MICHIGAN 48030

THE KROGER CO.

**jeffery a. scott architects p.c.**

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farmington, michigan 48336-3261  
(248) 478-8800 fax (248) 478-8833

**PARTIAL REFLECTED CEILING PLAN**

project no. 1211

sheet no. A-2

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